
## **GLENN HIGHWAY EROSION CONTROL MP 61-78 ADL 225669** 58035

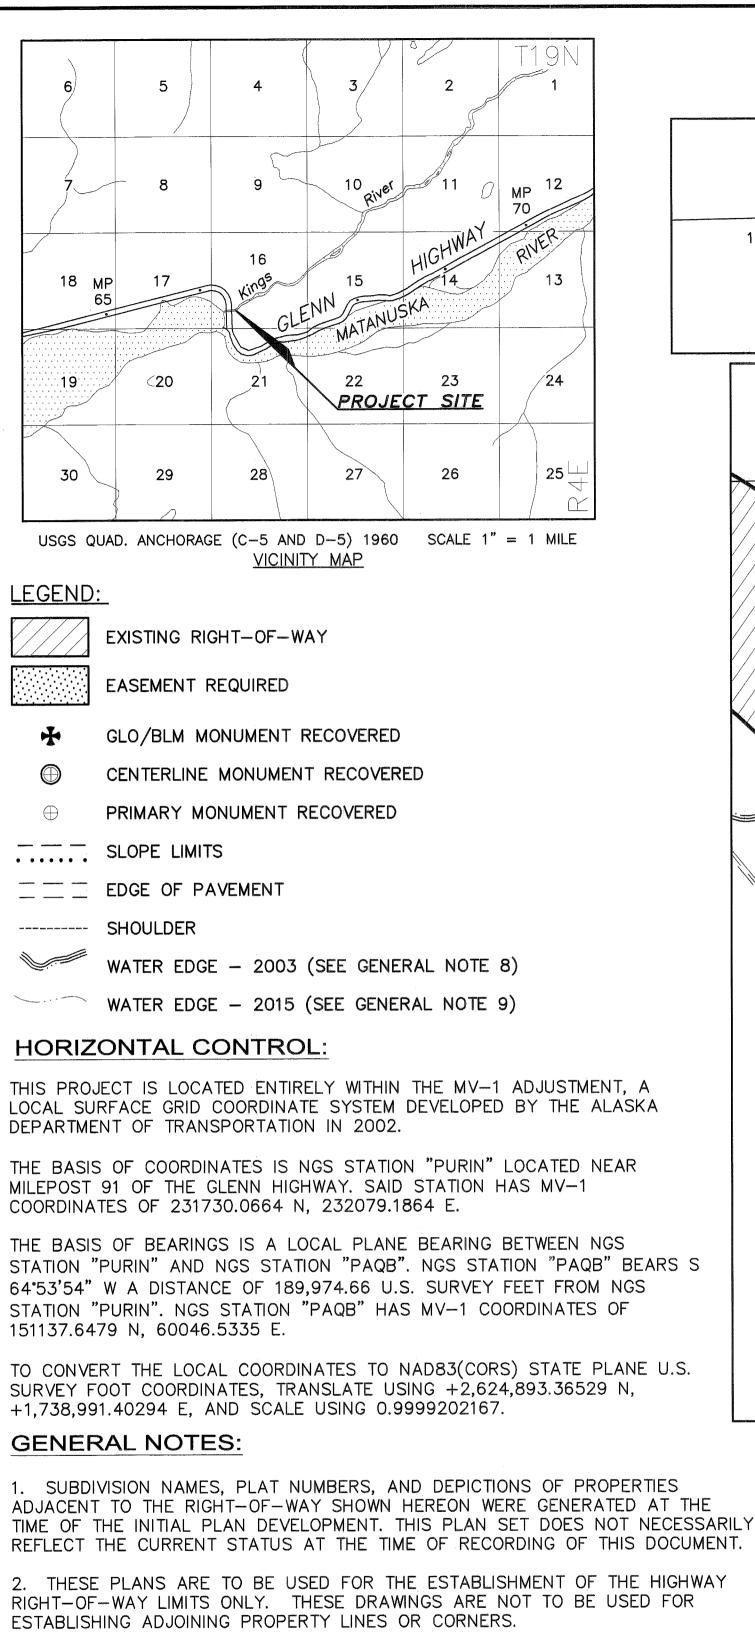

3. ALL DISTANCES ARE REDUCED TO HORIZONTAL GROUND DISTANCES IN FEET, UNLESS OTHERWISE NOTED.

4. EASEMENT SIDELINES ARE EXTENDED OR SHORTENED TO MEET AT ANGLE POINTS AND TERMINATE AT BOUNDARIES WITH NON-STATE LANDS.

5. ALL SURVEY DATA PRODUCED BY THIS AS-BUILT SURVEY IS NO LESS ACCURATE THAN ±0.26 FEET +200 PPMA RELATIVE TO ANY AND ALL OTHER POINTS IN THIS UPLAND SURVEY SEGMENT LOCATED WITHIN SECTION 36 TOWNSHIP


6. THE EXISTING RIGHT-OF-WAY IS FROM STATE OF ALASKA. DEPARTMENT OF TRANSPORTATION RIGHT OF WAY MAP. PROJECT 55967 GLENN HIGHWAY MP 66.5 TO 80 RECONSTRUCTION, PLAT 2015-16 PALMER RECORDING DISTRICT (PRD).

7. ALL PARCELS OF LAND OWNED BY THE STATE OF ALASKA, LOCATED WITHIN 50.00 FEET OF, OR BISECTED BY A SURVEYED OR PROTRACTED SECTION LINE, ARE SUBJECT TO A FIFTY FOOT (50') EASEMENT, EACH SIDE OF THE SECTION LINE, WHICH IS RESERVED TO THE STATE OF ALASKA FOR PUBLIC HIGHWAYS UNDER A.S. 19.10.010.

8. WATER EDGE - 2003: MEANDER LINES SHOWN ARE BASED ON AN AERIAL SURVEY COMPLETED IN 2003.

JULY 2015.

| 20 NC              | DRTH, RANG           | E 5 EAST, SEWARD M | ERIDIAN.         |                                     |          |           |                             | LOCATION                    | MONUMENT            | LOCAL<br>NORTHING | LOCAL<br>EASTING | STATE PLANE Z4<br>NORTHING | STATE PLANE Z4<br>EASTING | G<br>N |
|--------------------|----------------------|--------------------|------------------|-------------------------------------|----------|-----------|-----------------------------|-----------------------------|---------------------|-------------------|------------------|----------------------------|---------------------------|--------|
|                    | EASEMENT             | STATE OF ALASKA    | LARGE            | 6.428 AC                            | 6.428 AC | LARGE     | 2016-027208-0               | 1/4 S17/S16 *T19N R4E SM    | ALUMINUM CAP        | 204096.6369       | 117291.0004      | 2828764.296                | 1856134.303               | 61°4   |
| E-1                |                      | ADL 225669         |                  |                                     |          |           |                             | 1/4 S16/S21 *T19N R4E SM    | BRASS CAP [GLO]     | 201508.6714       | 119975.9316      | 2826176.537                | 1858819.020               | 61°4   |
| PARCEL<br>NO.      | INTEREST<br>ACQUIRED | OWNER              | LARGER<br>PARCEL | TAKE INCLUDING<br>EXISTING EASEMENT | NET TAKE | REMAINDER | DOCUMENT NUMBER<br>RECORDED | Glenn Highway EOP 19+345    | BRASS CAP BOX [DOT] | 202140.8128       | 118328.7352      | 2826808.628                | 1857171.955               | 61°4   |
| PARCEL INFORMATION |                      |                    |                  |                                     |          |           |                             | Glenn Highway PT 19+152.185 | BRASS CAP BOX [DOT] | 202772.7562       | 118300.6549      | 2827440.521                | 1857143.877               | 61° 4  |

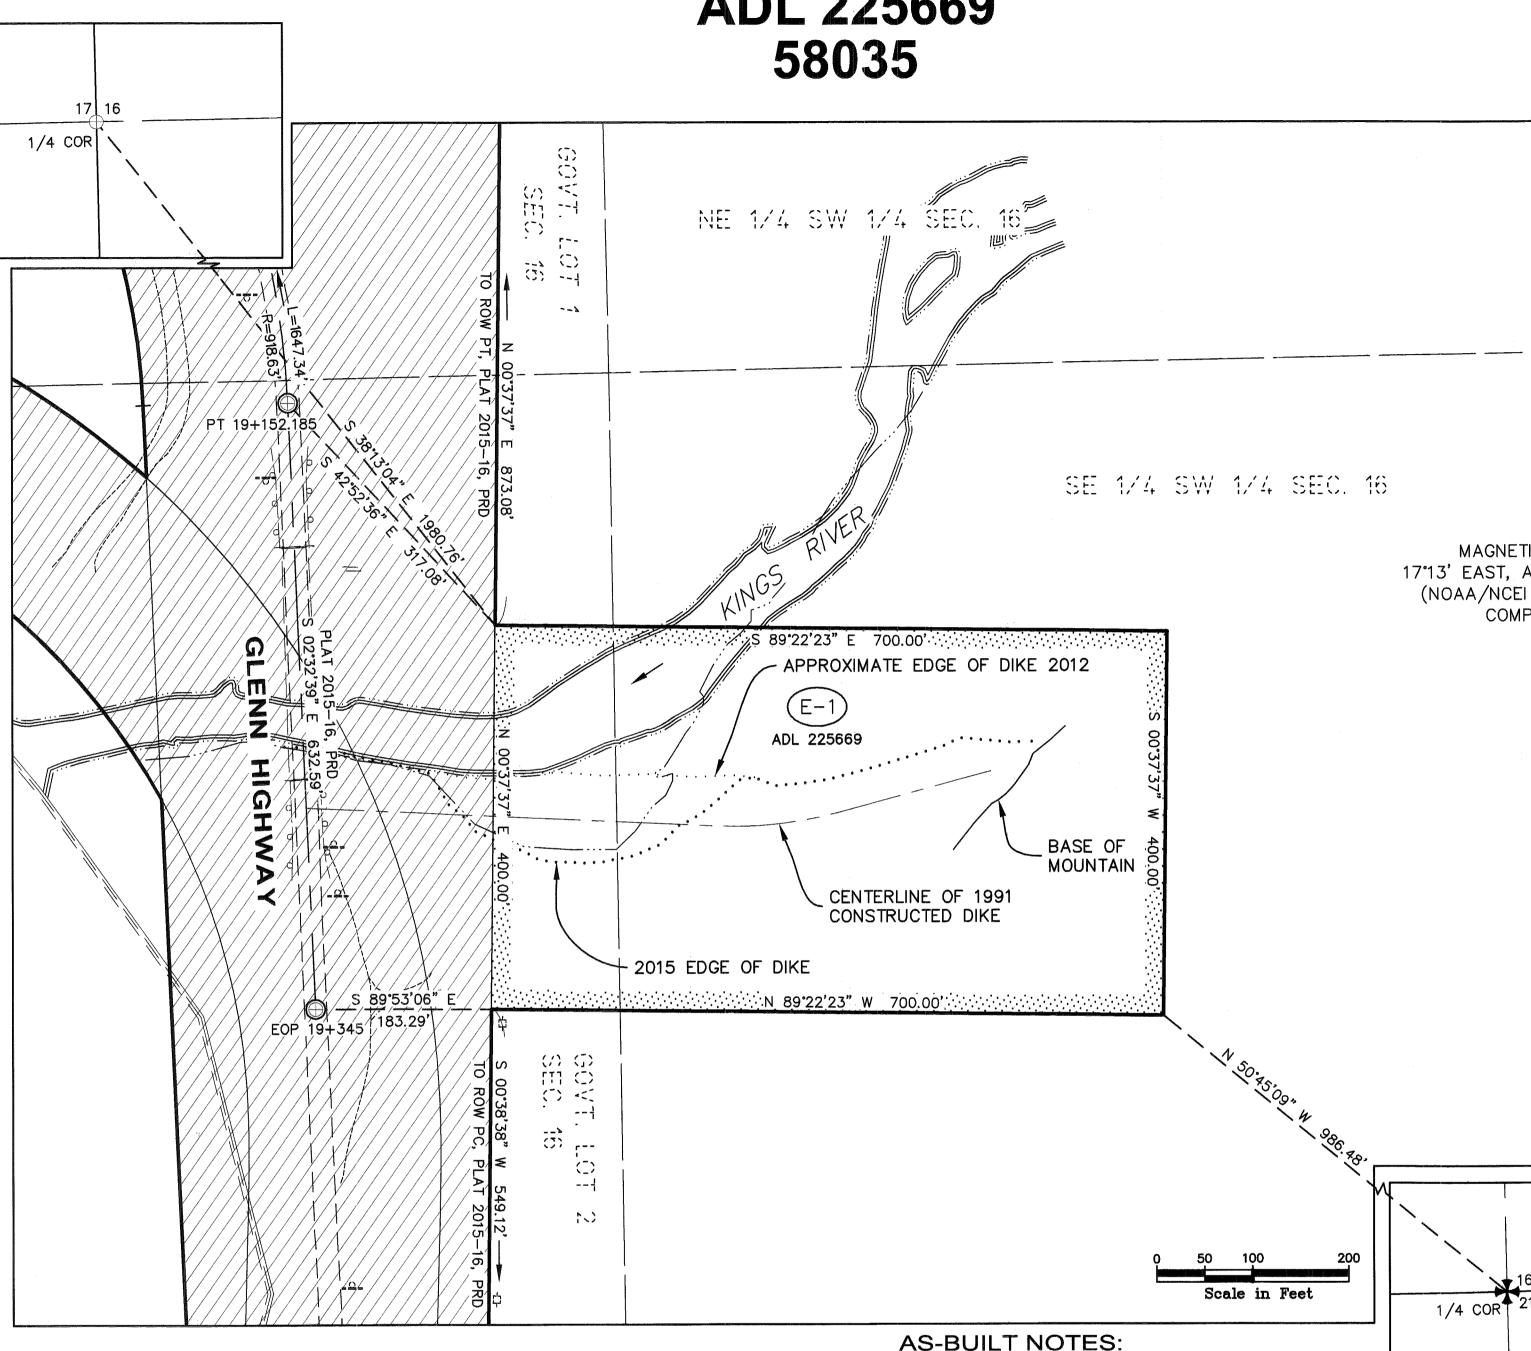

9. WATER EDGE - 2015: WATER EDGE SHOWN WAS SURVEYED BY AK DOT&PF IN

THIS AS-BUILT RECORD OF SURVEY REPRESENTS A POST-CONSTRUCTION SURVEY OF ADL 225669. ADL 225669 WAS INITIATED IN 1991 AND PERMITTED THE STATE OF ALASKA DEPARTMENT OF TRANSPORTATION AND PUBLIC FACILITIES TO INSTALL RIPRAP FOR EROSION CONTROL ON STATE LANDS. THIS RECORD OF SURVEY, EPF 20160057, IS THE AS-BUILT SURVEY OF ADL 225669.

2. THIS AS-BUILT REPRESENTS A POST CONSTRUCTION SURVEY OF ADL 225669. IT IS INTENDED TO DEPICT THAT PORTION OF THE EASEMENT AS IT PERTAINS TO STATE LAND AND IS NOT TO BE PRESUMED TO PLAT OR DEDICATE THOSE PORTIONS PERTAINING TO NON-STATE LANDS. THIS AS-BUILT IS NOT INTENDED TO BE USED TO RE-ESTABLISH PROPERTY BOUNDARIES. EXCEPT AS INDICATED, NO ENCROACHMENTS EXIST WITHIN THE PERMITTED AREA.

3. THE DIKE AT KINGS RIVER WAS ORIGINALLY CONSTRUCTED IN 1941 WITH THE CONSTRUCTION OF THE PALMER-RICHARDSON HIGHWAY. SINCE THAT TIME AKDOT&PF, AND ITS PREDECESSORS, HAVE MAINTAINED THE DIKE. PRIOR TO THE 1991 PROJECT, WHICH INSTALLED RIPRAP, THE DIKE WAS A GRAVEL BERM. IN 2012, AFTER A DNR SITE VISIT, THERE WAS A MAJOR FLOODING EVENT THAT WASHED OUT A SIGNIFICANT AMOUNT OF THE RIPRAP DIKE.

PROJECT DESIGNATION NO. SHEETS I-0A1-5(6) / 58035 DEPARTMENT LOCATIONS SURVEYOR'S CERTIFICATE I HEREBY CERTIFY THAT I AM A PROFESSIONAL LAND SURVEYOR REGISTERED IN THE STATE OF ALASKA AND THAT ALL RIGHT-OF-WAY CENTERLINE MONUMENT LOCATIONS HAVE BEEN ESTABLISHED AS INDICATED ON THE RIGHT-OF-WAY PLANS, ALL EXISTING FOUND SUBDIVISION MONUMENTS, PROPERTY CORNERS AND SECTION LINE MONUMENTATION AS INDICATED ON THE RIGHT-OF-WAY PLANS HAVE BEEN REFERENCED TO PROJECT SURVEY CONTROLS BY ME OR UNDER MY SUPERVISION. 9/20/16 45-11547 DATE REGISTRATION NUMBER TI<u>9N R 4E</u> S. M. \* 49 🖽 📉 Tec ke SEC.II6 ROBERT M. KEINER NO. L.S.-11547 ROBERT M. KEINER 7/20/16 STATE OF ALASKA DEPARTMENT OF TRANSPORTATION & PUBLIC FACILITIES 4111 AVIATION AVE ANCHORAGE, ALASKA 99502 (907)269-0700 MAGNETIC DECLINATION: 17°13' EAST, AUGUST 2, 2016 DEPARTMENT RIGHT-OF-WAY SURVEYOR'S CERTIFICATE (NOAA/NCEI GEOMAGNETISM HEREBY CERTIFY THAT I AM A PROFESSIONAL LAND SURVEYOR COMPUTATION, WMM REGISTERED IN THE STATE OF ALASKA AND THAT THIS PLAT WAS MADE BY ME OR UNDER MY SUPERVISION. THIS PLAT WAS BASED UPON THE MONUMENTS RECOVERED DURING THE DEPARTMENT'S LOCATIONS SURVEY FOR THIS PROJECT. OF 9/22/16 05-610 REGISTRATION NUMBER \* 49世 次 P. LOUISE HOOYER B. NO. L.S.-6109 P. LOUISE HOOYER STATE OF ALASKA DEPARTMENT OF TRANSPORTATION & PUBLIC FACILITIES PROFESSION 4111 AVIATION AVE ANCHORAGE, ALASKA 99502 (907)269-0700 DEPARTMENT OF TRANSPORTATION AND PUBLIC FACILITIES APPROVED SEPTEMBER 22, 2016 REGIONAL CHIEF RIGHT-OF-WAY AGENT 2017-14 Plat # Palmer Rec Dist Jon 23 2017 me\_11:47A THIS SURVEY DOES NOT CONSTITUTE A SUBDIVISION AS DEFINED BY A.S. 40.15.900(5). STATE BUSINESS-NO FEE STATE OF ALASKA DEPARTMENT OF NATURAL RESOURCES DIVISION OF MINING, LAND, AND WATER AND PUBLIC FACILITIES ANCHORAGE ALASKA RECORD OF SURVEY DOC:TITLE:RS-DOT KINGS RIVER DIKE AS-BUILT GTE: 1. ADL 225669 2. KINGS RIVER ON GLENN HIGHWAY GLENN HIGHWAY EROSION CONTROL MP 61-78 4. ALASKA PROJECT I-0A1-5(6) / 58035 5. KINGS RIVER DIKE 6. AS-BUILT SURVEY IN SUPPORT OF RIGHT OF WAY EASEMENT LOCATED WITHIN: SECTION 16, TOWNSHIP 19 NORTH, RANGE 4 EAST GEODETIC GEODETIC SEWARD MERIDIAN, ALASKA PALMER RECORDING DISTRICT EASTING NORTHING NR APPROVAL: STATEWIDE PLATTING SUPERVISOR 2700-2016 62 - Estables Branch 44' 11.94367" N 148° 45' 20.58232" GNATURE STANLEY BROWN 43' 45.95868" N 148° 44' 25.88973" W DATES OF SURVEY BEGIN: JULY 2015 END: AUG 2015 148° 44' 59.82160" W 43'52.49436"N DRAWN BY: RVK DRAWN DATE: 4/11/16 SHEET 1 OF 1 43' 58.72062" N 148°45'00.15233" W SCALE 1'' = 100'CHECKED BY: epf EPF 20160057